SHERBAT AREA VANIANCE TO ADD A SECOND STORY TO AN CONSTING GAPAGE FOR ADDITIONAL STORAGE	BOARD OF APPEALS of Owasco, New York r Interpretation or Variance FICE USE ONLY officer. Define part of ordinance in question Case No. Date Rec'd BA Date Hearing Date Action Action
A. Statement of Ownership and Interest	
1. The applicant(s) Mithed Coffe	A Section of the sect
(is) (are) the owner(s) of property situated at	317 Natoro Edge, Auburn, My 13021
C. Attach copy of Plot Plan Sign Telephone No. 607-160-7494	nature(s) MGP8-14-
Cell No.	

AMERICAN AND AND AND AND AND AND AND AND AND A			

Town of Owasco 2 Bristol Avenue Auburn, New York 13021

J. Patrick Doyle
Code Enforcement Officer
Email: codes@owascony.gov

Office Phone: 315-253-9021

Fax: 315-253-2683

Cell Phone: 315-729-3921

Application for Building/Zoning Permit (Not a Permit)

IMPORTANT INSTRUCTIONS, PLEASE READ CAREFULLY.

- 1. Application must be complete. Please type or clearly print in ink all necessary information.
- 2. Completed Application must be submitted to the Owasco Town Clerk with appropriate fee before review process can begin.
- 3. Application must be supported with the following documents:

MINOR PROJECT: A. Plot plan (see attached sample)

B. Sketch of project and/or specifications/materials list.

MAJOR PROJECT: A. Three (3) copies of plot plan signed

- B. Three (3) copies of design drawings signed and sealed by a licensed architect or licensed professional engineer.
- C. One (1) copy of approval from developer, if in Planned Development District.

BURANE COMBU	<u>ere</u> ;	ā	
Location of proper	ty: 317 WATERS (Street or Firelane No., Lot No.,	Nearest Road)	RURN
Tax Map No.:	138.01-1-	34	
Name of Owner:	MICHAEL COP	XX.	
Address:	317 WATE	2S EDE	100-11
Phone, Email	6072760 (Phone) (Cell)	7494 <u>M@M</u> (Email)	COPPOCA. COM

Application for Building/Zoning Permit (continued)

A. PROJECT CONTACTS:	1					
Builder (If self, so indicate) KEVIN HORNING						
Address						
Phone / Cell / Email 3/5 923	1233					
Architect or Engineer DAVIDS	ECO Z					
Address						
Phone / Cell / Email 3/6	3/235					
B. NATURE OF WORK (CHECK ALL APPROP	RIATE CATEGORIES BELOW):					
1. Repair (structural) 2. Addition 3. Alteration	4. Removal 5. Demolition 6. Other (specify)					
New Struc	zture(s)					
Single Family Accessory Buildings: Garage:AttachedDetached Shed	3. Two Family 4. Deck:CoveredOpen 5. Swimming Pool:AboveBelow 6. Other (specify)					
C. PRINCIPAL CONSTRUCTION MATERIAL TO BE USED	<u>):</u>					
1. Wood 2. Brick	3. Block 4. Other (Specify)					
D. TYPE OF FOUNDATION:						
1. Cellar 2. Slab 5. Other (Specify)	3. Basement 4. Crawlspace					
E. COMPLETE THE FOLLOWING:						
1. Water Source: Public Private	WellOther					
2. Sewage: Public Private * If private, has sewage	disposal permit been applied for Yes No					
3. Will the project involve plumbing?	No X					
4. Will the project involve H.V.A.C.?	No					
5. Will the project involve electrical?	No					
F. COST OF THIS PROJECT: (all labor* and materials) * estimate your labor, if applicable.	\$ 260,000					

Application for Building/Zoning Permit (continued)

G. ZONING DISTRICT OF PRO	PERTY (Circle One) 7		
1. Residential	2. Agricultural/Residential	3. Lakeshor	9
H. PRINCIPAL USE OF PRESI	ENT STRUCTURE(S) AND/O	R LAND (Circle One)	
1. Residential	2. Agricultural/Residential	3. Lakeshor	e
4. Other (Specify)			
I. PRINCIPAL USE OF THIS P	ROPOSED PROJECT. (Desc		
J. DIMENSIONS OF TOTAL P			
Lot size: Length	(X) Width	(=) Total	sq. ft
Existing Buildings: Length	(X) Width	(=) sq. ft	•
Length	(X) Width	(=) sq. ft	
Length	(X) Width	(=) sq. ft	
	ED PROJECT (If applicable)		
Length 40	(X) Width 24	(=) Total sq. ft.	
Height	Number of stories		
L. PROPERTY LINE SETBA	CKS OF PROPOSED PROJE	ECT. (If applicable)	
Front lot line setback	ft <u>.</u>	Side lot line setback	ft.
Rear lot line setback	ft.	Side lot line setback	ft,
M. ENCLOSED LIVING ARE	A. (if applicable)	Total sq. Ft.	
GENERAL	INFORMATION PERTAININ	IG TO THIS APPLICA	TION
This <u>application</u> will be rev Engineer. If disapproved, a le approved, a <u>BUILDING/ZONII</u>	lewed by the Code Enforcementer of denial explaining reason NG PERMIT will be issued to the second control of	n(s) for denial will be is	own Consulting sued to applicant. If
Wash navened by this ADD	LICATION		

Work covered by this <u>APPLICATION</u> shall not commence prior to the issuance of a <u>PERMIT</u>. The <u>PERMIT</u> shall be valid for a period of twelve (12) months from the date of issuance. Construction under the PERMIT must be substantially complete within twelve (12) months or an extension must be obtained from the Code Enforcement Officer. <u>A NOTICE OF PERMIT</u> (issued by the Town) must be kept on the premises, publicly visible, throughout the progress of work.

the Code Enforcement Officer. A NOTICE OF PERMIT (issued by the Town) must be kept on isses, publicly visible, throughout the progress of work.

3

Application for Building/Zoning Permit (continued)

This project may involve work requiring approval of various outside agencies. Certain outside agency approvals may be required prior to the issuance of a Permit. Final approval of all agencies involved must be submitted to the Code Enforcement Officer prior to the issuance of a Certificate of Occupancy or Compliance. Examples, not limited to the following, would be:

Project Involvement

Agency

1. Land division, SEQR, etc.

2. Zoning matters, SEQR

3. Public water, sewer

4. Private septic system

5. N.Y.S. Roads

6. Floodplains, wetlands

7. Streams, Lakes, etc.

Owasco Planning Board

Owasco Zoning Board of Appeals

Owasco Water, Sewer Departments(s)

Cayuga County Health Department

NYS Dept. of Transportation

NYS Dept. of Environmental Conservation

U.S. Army Corps of Engineers

Application for a CERTIFICATE OF OCCUPANCY OR COMPLIANCE is made concurrently with this filing. It is the responsibility of the owner or authorized agent to notify the Code Enforcement Officer when the project is completed in order to obtain a Certificate of Occupancy or Compliance.

The Town Code Enforcement Officer and/or Building Inspector, upon the display of proper credentials and in the discharge of his duties, shall be permitted to enter upon the premises covered by this <u>application</u> with out interference, for the purposes of inspecting, during normal working hours.

No person shall make any changes to the plans herewith submitted or of the specifications herein contained in the structural part of the project without the written consent of the Code Enforcement Officer.

I certify that the answers to the questions set forth in this <u>APPLICATION</u> are true, correct and complete. Additionally, I agree that, in the event the <u>PERMIT</u> is approved, to comply with the provisions of all State of New York and Federal Government laws, rules and regulations, as they pertain this <u>APPLICATION</u>.

Signature:

er of enthorized agent)


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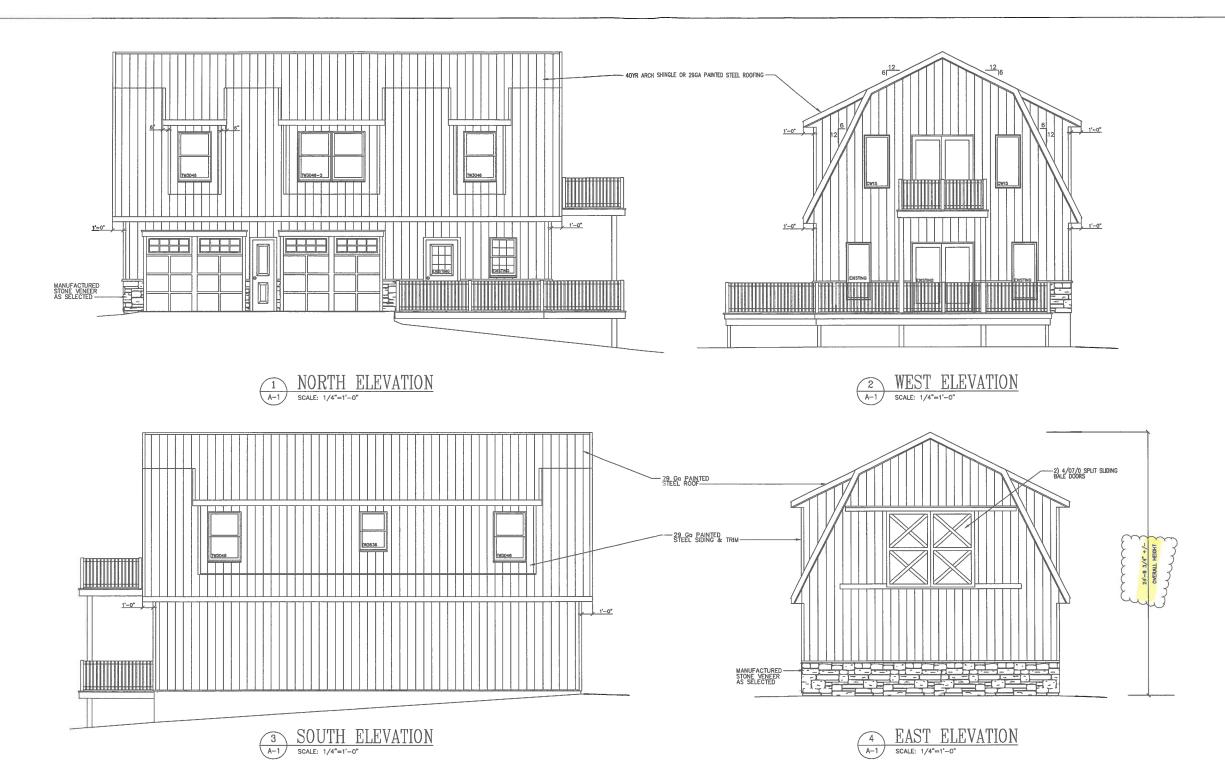
OWASCO LAKE LOCATION MAP OF PROPERTY OF BLAIR LONGO
LOT 7, LOT 8 AND 3 FOOT of LOT 9 MAP 2-92 minus B.L.A. B
GREAT LOT NO. 84 EAST SHORE OWASCO LAKE
TOWN OF OWASCO CAYUGA COUNTY NEW YORK
AUGUST 2, 1997 SCALE:1IN.=50FT
EUGENE J. GLEASON, L. S. N.Y.S. LICENSE NO. 022437-1 ileason, Licensed Land Serveyor, certify to CoreStates Bank, N.A., its successors and for assigns, Fidelity Notional Title Institute and New York and News Investments & Consulting Services, that this is a free and accurate survey prepared in accordance with 1 and Surveyors, and that there are no easythem is, or rights of way than shown.

[1] [1] [1] [2] [3] SHORE 36.00 M. S. Const. No To Park 41.48 Book 346 Page 892 8597 2.00 BAN2-92 To Kind Land 9 & b A.Y.S. Rr. SEA 12.5 RICHT OF WAY

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GENERAL SPECIFICATIONS

DESIGN CRITERIA:

THESE DRAWNGS HAVE BEEN PREPARED IN ACORDANCE WITH THE NEW YORK STATE RESIDENTIAL BUILDING CODE AND MEETS OR EXCEEDS THE CURRENT ENERGY CONSERVATION CODE. CONTRACTOR SHALL VERIFY ALL DIMENSIONS INDICATED ON PLANS PRIOR TO THE START OF ANY WORK, REPORT ALL DISCORDED AND START OF ANY WORK, REPORT AND START OF ANY WORK, REPORT 42 PSF LIVE LOAD, TC DL 7 PSF LIVE LOAD BC DL 10 PSF LIVE LOAD

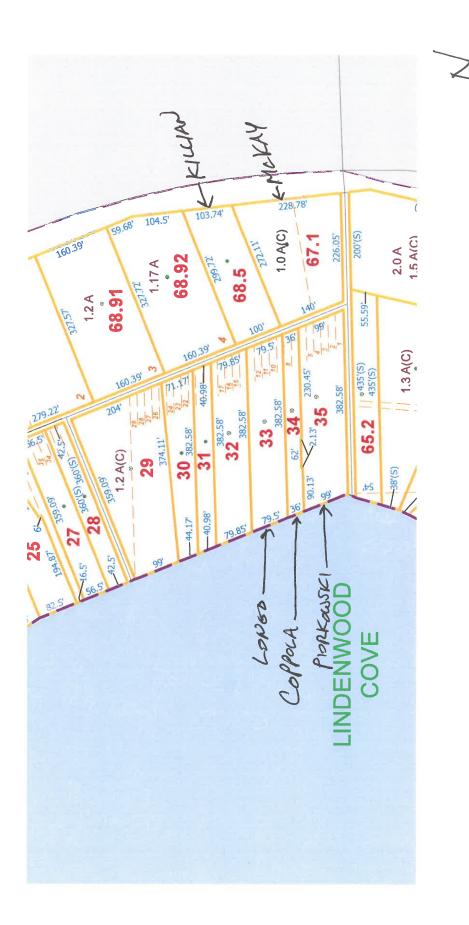- SOIL BEARING - SNOW :

2000 PSF MIN. 50 PSF GROUND LOAD ADJ. W/ ROOF PITCH

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FOUNDATION/CONCRETE

- P.T. POST ENDS PLACED ON BOLBS. OR 160 LBS. DRY MIX SAVRETE WITH ONSTE COMPACTED BACKFILL MATERIAL. CONCRETE SUBJECTED TO FREEZE THAW CYCLES SHALL HAVE A MINIMUM COMPRESSIVE STRENGTH OF 3500 PSI ARE ENTRAINED AS PER TABLE R402.2 OF THE MYS RESIDENTIAL BUILDING CODE.

WALL CONSTRUCTION - POST FRAMED WALL ASSEMBLY UNLESS NOTED OTHERWISE. - INSULATED EXTERIOR WALL CAVITIES WITH MIN. R-19 FIBERGLASS BATTS SECURELY ATTACHED TO ADJACENT STUDS AS PER MANUFACTURERS RECOMENDATIONS WHERE SHOWN. 2x4 INTERIOR STUD WALLS © 16° O.C., UNLESS NOTED OTHERWISE.
 CLAD WITH PAINTED STEEL WALL LINER.

— MINIMUM 7-6" CELING HIGHT OR AS NOTED ON PLANS.

— INSTALL FIRE BLOCKING IN ACCORDANCE WTH SECTIONS R314.8, R602, R1001.16 OF THE RESCENTIAL BUILDING CODE. INSTALL FIREBLOCKING IN CONCEALED WALL STAR, FLOOR AND CELING AS REQUIRED. 5/8" TYPE." GWB ON UNDERSIDE OF STAIRWAYS. - ALL WINDOWS SHALL BE VINYL COVERED WOOD, LOW E ANDERSEN OR EQUAL WITH STOOLS AND SCREENS GRILLES ARE OPTIONAL AS PER OWNER.

- ALL WINDOW HEADERS TO BE 2) 2x10 MINIMUM UNLESS NOTED OTHERWISE, PROVIDE 2 PLY JACK STUD IF SPAN IS MORE THAN 4 FEET WOLE. ROOF AND CEILING CONSTRUCTION

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ENERGY CONSERVATION CONSTRUCTION CODE - SEE ATTACHED RESCHECK COMPLIANCE CERTIFICATE.

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- 200 AMP, 40 SPACE MAIN SERVICE PANELBOARD.

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— RECEPTACLES INSTALLED AT UNFORM HEIGHTS THROUGHDES AND RECEPTACLES INSTALLED AT UNFORM HEIGHTS.

— CAPIC SMOKE DETECTORS ARE REQUIRED IN THE FOLLOWING LOCATIONS OF ON EACH FLOOR OF THE HOUSE INCLUDION THE BASEMENT. ON ELECATED OUTSIDE OF A HERDOOM.

(HE SMOKE DETECTORS SHALL BE HAND WRED AND INTERCONNECTED)

— CARBON MONDRED ETECTORS ARE; REQUIRED IN THE FOLLOWING LOCATIONS: ON EMERY FLOOR WITH A REDPOOM.

NEISE A REDPOOM WITH A FUEL FIRE APPLIANCE (EX. PREPLACE).

(A COMBO SMOKE/CARBON DETECTOR CAN BE USED ON ALL FLOORS)

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EXHAUST FANS IN BATHROOMS WITHOUT OPERABLE MINDOWS SHALL HAVE 30 CFM INTERMITTENT OR 20 CFM CONTINUOUS VENTILATION. EXHAUST VENT PIPES SHALL BE SOLID PIPE AND VENTED TO EXTERIOR A MINIMUM OF 3 FT FROM ANY OPENING, 10 FT FROM AIR INTAKE, THE LENGTH SHAL NOT EXCEED THAT LISTED IN TABLE M 1506.2. - VENTS FOR CLOTHES DRYERS SHALL HAVE A SMOOTH INTERIOR SURFACE, BE MADE OF METAL, BE 4" MIN. IN DIA. AND 28GA WITH A LENGTH NOT EXCEEDING 35 FT. SEE TABLE M 1507.3.3.

- RANGE HOODS FOR GAS APPLIANCES SHALL EXHAUST TO THE EXTERIOR PER SECTION M 1503.

EXTENSIVE PROPRIET TO THE SECTION M 1003.

TO SECTION M 11507 AND TABLE M 1507.3.3.

PLIMBERS (INCLUDION WATER, SOL. OR SANITARY LINES SHALL NOT BE INSTALLED OUTSIDE OF THE BUILDING EXTERIOR WALLS OR IN ATTICS OR CRAW. SPACES, OR ANY OTHER PLACE WHERE FREEZING CAN COCUR UNLESS PROVISIONS ARE MADE TO INSULATE OR HEAT THE LINES.

nning engineering c
o west church street savannal
ph. 315.365.2838 fax. 315. planning

This drawing is the property of Secor Engineering. Reproduction alternation, or use without the written consent of Secor Engineering is problibited. Drawings shall not be easiled to obtain dimensions. The contractor and huddless involved on this project shall review and veril all dimensions prior to the start of any related work. Report any discrepancy found to the engineer of record in writing before proceeding with any related work.

ering construction savannah, new york 13146 fax. 315.365.3434

13140

Structural Engineer:
SECOR ENGINEERING
SERVICES

13140 Route 31 Savannah, New York 13146 315-365-2838

General Contractor:

Project:

Coppola FOR: RECONSTRUCTION McGowan and Mike

YORK NEW WATERSEDGE OWASCO,

317 OF C

TOWN

Molly

ELEVATIONS

Plan: Seal:

GARAGE ROOF



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Drawn By: JRM
Project Number: 2745-2047
Sheet: A-1 of: 4
Pavisions:

06/01/20 PERMIT SET



GENERAL SPECIFICATIONS

DESIGN CRITERIA:

 THESE DRAWINGS HAVE BEEN PREPARED IN ACORDANCE WITH THE NEW YORK STATE RESIDENTIAL BUILDING CODE AND MEETS OR EXCEPTS THE CURRENT ENERGY CONSERVATION CODE CONTRACTOR SHALL VERIFY ALL DIMENSIONS INDICATED ON PLANS PRIOR TO THE START OF ANY WORK REPORT ALL 42 PSF LIVE LOAD, TC DL 7 PSF LIVE LOAD BC DL 10 PSF LIVE LOAD

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FOUNDATION/CONCRETE

- P.T. POST ENDS PLACED ON BOLBS, OR 160 LBS, DRY MIX SAKRETE WITH ONSTE COMPACTED BACKFILL MATERIAL. - Concrete subjected to freeze than cycles shall have a minimum compressive strength of 3,500 psi Air Entrained as per table r402.2 of the Nys residential balding code.

WALL CONSTRUCTION
- POST FRAMED WALL ASSEMBLY UNLESS NOTED OTHERWISE. - INSULATED EXTERIOR WALL CAVITIES WITH MIN. R-19 FIBERGLASS BATIS SECURELY ATTACHED TO ADJACENT STUDS AS PER MANUFACTURERS RECOMENDATIONS WHERE SHOWN. - 2x4 INTERIOR STUD WALLS © 16" D.C., UNLESS NOTED OTHERWISE. CLAD WITH PAINTED STEEL WALL LINER. - MINIMUM 7'-6" CEILING HEIGHT OR AS NOTED ON PLANS.

- MINIMUM / -B ELLING HIGHT OF AS NOTED ON POST AS - INSTALL FIRE BLOCKING IN ACCORDANCE WITH SECTIONS R314.8, R602, R1001.18 OF THE RESIDENTIAL BUILDING CODE. INSTALL FIREBLOCKING IN CONCEALE WALL, STAR, FLOOR AND CEILING AS REQUIRED, 5/8" TYPE "X" GWB ON UNDERSID OF STARWAYS - ALL WINDOWS SHALL BE VINYL COVERED WOOD, LOW E ANDERSEN OR EQUAL WITH STOOLS AND SCREENS: GRILLES ARE OPTIONAL AS PER OWNER. - ALL MINDOW HEADERS TO BE 2) 2x10 MINIMUM UNLESS NOTED OTHERWISE, PROVIDE 2 PLY JACK STUD IF SPAN IS MORE THAN 4 FEET WIDE.

ROOF AND CEILING CONSTRUCTION

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OVERHANG AS INDICATED ON DRAWINGS.

ENERGY CONSERVATION CONSTRUCTION CODE

- SEE ATTACHED RESCHECK COMPLIANCE CERTIFICATE.

ELECTRICAL

- ALL ELECTRICAL INSTALLATIONS BY CUALIFIED ELECTRICIAN
WRED AS SECTION SECTION SECTION OF THE MAJORIAL TRESTRICAL CORD AND THE RESIDENT WAS EXCENDED.

TOWN APPROVED INSTRUCTION ASSISTS ARE REQUIRED.

- 200 AMP, 40 SPACE MAIN SERVICE PANELBOARD.

- MINIMUM OF 2 EXTERIOR MATERPROCO ROUND FAULT INTERRUPTERS.
- GROUND FAULT INTERRUPTER RECEPTACLES IN NEAREST LOCATION TO
MIN OR DATA
- ALL SWITCHES AND RECEPTACLES INSTALLED AT UNIFORM HEIGHTS
- THROUGHOUT.

THROUGHOUT:

- AC/DC SMOKE DETECTORS ARE REQUIRED IN THE FOLLOWING LOCATIONS:
ONE ON EACH FLOOR OF THE HOUSE INCLUDING THE BASEMENT.
ONE LOCATED OUTSIDE OF A BERROOM.

(THE SMOKE DETECTORS SHALL SE HARD WRED AND INTERCONNECTED)
ON EVERY FLOOR WITH A BEDROOM.
INSDEA A BERROOM SHALD HAVE DEPLAYED,
THE BASEMENT WHEN A FUEL TREED APPLIANCE (EX, FIREPLACE).
THE BASEMENT WHEN A FUEL TREED APPLIANCE (SLOCATED THERE.
(A COMED SMOKE/CARGINO TEXTURE ON A USED ON ALL FLOORS)

- ARC-FAULT CIRCUIT-INTERRUPTER PROTECTION(AFCI) IS REQUIRED ON ALL 15 AND 20 AMFERE BRANCH CIRCUITS SUPPLYING OUTLIETS INSTALLED IN DWELLING UNITS IN THE FOLLOWING AREAS:

ELECTRICAL CONT.

ELECTRICAL CONT.
FAMILY ROOMS
DINING ROOMS
JUME ROOMS
PARLORS
BEDROOMS
SURFOOMS
BEDROOMS
SURFOOMS
RECEENTON ROOMS

AREAS THAT DO NOT REQUIRE ARC FAULT PROTECTION:
NITCHENS
BATHROOMS
OUTDOORS
UNFINISHED BASEMENTS

FIXTURES SHALL BE HIGH-EFFICACY LAMPS.

LECTRICAL AND PLUBIAGING INSTALLATIONS SHALL MEET OR

EXCEPT LOCAL & NATIONAL CODE REQUIREMENTS AND SHALL

EN INSPECTED IN ACORDAINCE WITH APPLICABLE LAWS.

SMOKE & CARBON MONOXIDE DETECTORS SHALL BE DIRECT

MINED AND CONFORM TO SECTION R—314 OF THE RESIDENTIAL

CODE. A CARBON MONOXIDE DETECTOR SHALL BE INSTALLED

WITHIN EACH DIVELLING UNIT OR ANY FLOOR HAWING AREAS

FOR SLEEPING AS PER SECTION R—315.

MECHANICAL

- EXHAUST FANS IN BATHROOMS WITHOUT OPERABLE WINDOWS SHALL HAVE 30 CPM INTERMITTENT OR 20 CPM CONTINUOUS VENTILATION.

 EXHAUST VENT PIPES SHALL BE SOLID PIPE AND VENTED TO EXTERIOR A MINIMUM OF 3 FT FROM ANY OPENING. 10 FT FROM AIR INTAKE.
 THE LENGTH SHAL NOT EXCEED THAT LISTED IN TABLE M 1506.2. - VENTS FOR CLOTHES DRYERS SHALL HAVE A SMOOTH INTERIOR SURFACE, BE MADE OF METAL, BE 4" MIN. IN DIA. AND 28GA WITH A LENGTH NOT EXCEEDING 35 FT. SEE TABLE M 1507,3.3.

- RANGE HOODS FOR GAS APPLIANCES SHALL EXHAUST TO THE EXTERIOR PER SECTION M 1503.

- WHOLE-BUILDING MECHANICAL VENTILATION SYSTEMS SHALL CONFORM TO SECTION M 11507 AND TABLE M 1507.3.3.

PELIMBRING LUDION WATER, SOLI OR SANTRAPY LINES SHALL NOT BE INSTALLED OUTSIDE OF THE BUILDING EXTERIOR, WALLS OR IN ATTICS OR CRAM, SPACES, OR ANY OTHER PLACE WHERE FREEZING CAN OCCUR UNLESS PROVISIONS ARE MADE TO INSULATE OR HEAT THE LINES.

uning engineering construction west church street savannah, new york 13146 ph. 315.365.2838 fax. 315.365.3434 enal: engineering@scorbuildingolubus.con planning 6

Structural Engineer: SECOR ENGINEERING SERVICES

13140 Route 31 Savannah, New York 13146 315-365-2838

General Contractor:

Project:

ROOF

GARAGE

Seal:

David E

Coppola FOR: RECONSTRUCTION Mike and

WATERSEDGE McGowan 317

YORK

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Molly Plan:

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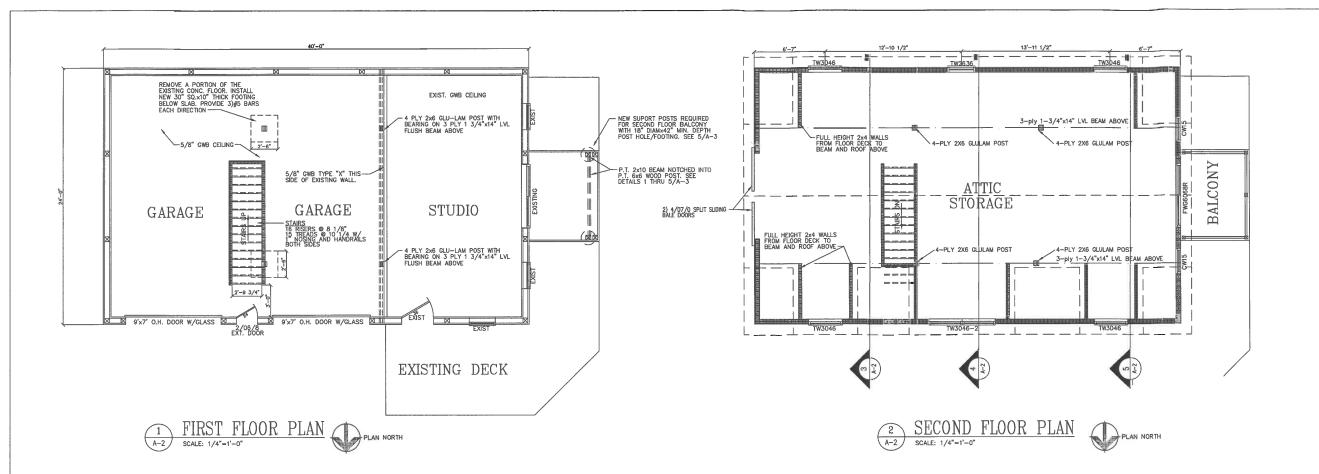
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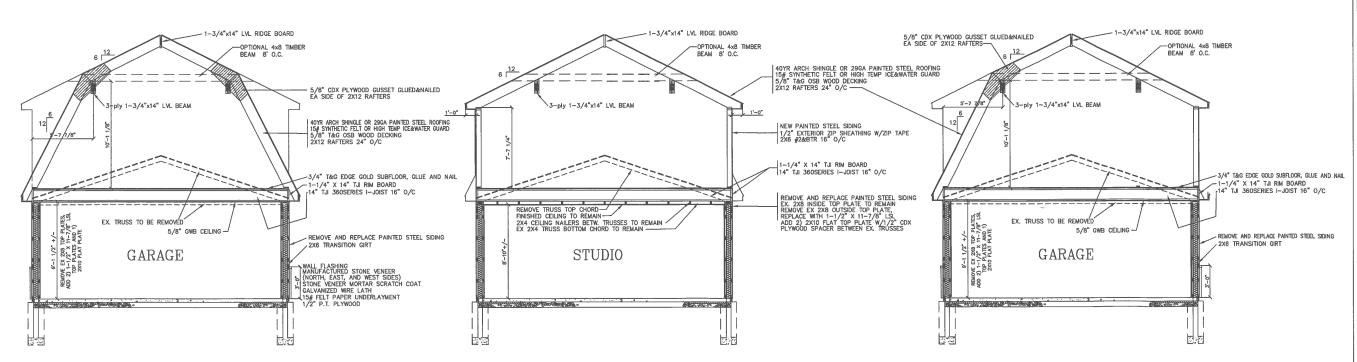
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Project Number: 2745-2047

Sheet: A-1 of: 4

Revisions: 06/01/20 PERMIT SET





3 SECTION OVER GARAGE SCALE: 1/4"=1'-0"

SECTION OVER STUDIO THRU DORMER SCALE: 1/4"=1'-0"

5 SECTION OVER GARAGE SCALE: 1/4"=1'-0"

ering construction savannah, new york 13146 fax. 315.365.3434 uing engineering cast church street savannal 1. 315.365,2838 fax. 315. SECOR 13140

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General Contractor:

Project:

Coppola RECONSTRUCTION Mike and McGowan ROOF GARAGE

NEW

OWASCO,

WATERSEDGE

317 OF

Molly

Seal:

FLOOR PLANS & SECTIONS

David E


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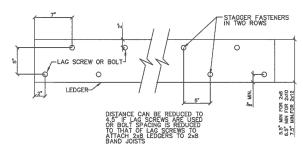
Date: MAY 27, 2020 Scale:

Drawn By: JRM Project Number: 2745-2047


Sheet: A-2 of: 4 Revisions

06/01/20 PERMIT SET



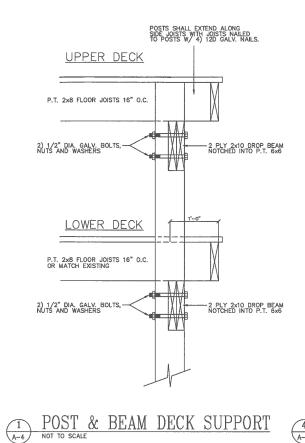


FASTENER PLACEMENT IN LEDGERS

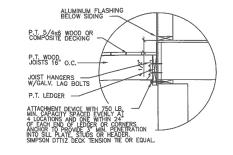

DECK LATERAL LOAD CONNECTION

SCALE: 1"=1'-0" PER R507.2.4

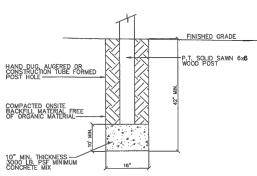

TYPICAL POST FOOTING

TABLE R507.2 IRC
DECK LEDGER CONNECTION TO BAND JOIST

	JOIST SPAN						
CONNECTION DETAILS	6' AND LESS	6'-1" TO 8'-0"	8'-1" TO 10'-0"	10'-1" TO 12'-0'	12'-1" TO 14'-0	14'-1" TO 16'-0	16'-1" TO 18'-0
		ON-CENTER SPACING OF FASTENERS					
1/2" DIA. LAG SCREW WITH 1/2" MAXIMUM SHEATING ^{4,4}	30	23	18	15	13	11	10
1/2" DIA. BOLT WITH 1/2" MAXIMUM SHEATING	36	36	34	29	24	21	19
1/2" DIA. BOLT WITH 1" MAXIMUM SHEATING®	36	36	29	24	21	18	16

- Q. LEDGERS SHALL BE FLASHED IN ACCORDANCE WITH SECTION R703.4 TO PREVENT WATER FROM CONTACTING THE HOUSE BAND JOIST.
 D. SHOW LOAD SHALL NOT BE ASSUMED TO ACT CONCUPRENTLY WITH THE LIVE LOAD.
 C. THE TIP OF THE LAG SCREW SHALL FULLY EXTEND BEYOND THE MISDE FACE OF THE BAND JOIST.
 d. SHEATHING SHALL BE WOOD STRUCTURAL PANEL OR SOLID SAWN LUMBER.
 G. SHEATHING SHALL BE PERMITTED TO BE WOOD STRUCTURAL PANEL OR SUBSTITUTE FOR UP TO 1/2 INCH OF ALLOWABLE SHEATHING. UP TO 1/2 INCH DISTRUCTURAL PANEL OR SUBSTITUTE FOR UP TO 1/2 INCH OF ALLOWABLE SHEATHING. THICKNESS WHERE COMBRED WITH WOOD STRUCTURAL PANEL OR FURBER SHEATHING.

TABLE R507.2.1 IRC
PLACEMENT OF LAG SCREWS AND BOLTS IN DECK LEDGERS AND BAND JOISTS

MINIMUM END AND EDGE DISTANCES AND SPACING BETWEEN ROWS						
TOP EDGE BOTTOM EDGE ENDS ROW SPACIN						
LEDGER *	2 INCHES ⁴	3/4 INCH	2 INCHES ^b	1 5/8 INCHES		
BAND JOIST *	3/4 INCH	2 INCHES	2 INCHES ^b	1 5/8 INCHES		

- a. LAG SORES OR BOLTS SHALL BE STAGGERED FROM TOP TO BOTTOM ALONG THE HORIZONTAL RUN OF THE DECK LEDGER IN ACCORDANCE WITH FIGURE R507.2.1(1).
 b. MAXIMUM 5 INCHES.
 c. FOR ENONLEERED RIM JOSTS, THE MANUFACTURER'S RECOMMBIDATIONS SHALL GOVERN.
 d. THE MINIMUM DISTANCE FROM BOTTOM ROW OF LAG SORENS OR BOLTS TO THE TOP EDGE OF THE LEDGER SHALL BE IN ACCORDANCE WITH FIGURE R507.2.1(1).

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General Contractor:

Project:

GARAGE ROOF RECONSTRUCTION FOR:

Coppola Molly McGowan and Mike

317 WATERSEDGE OF OWASCO, NEW NEW TOWN

YORK

SECTIONS & DETAILS

Seal:

David E

Secor Date: MAY 27, 2020 Scale: AS NOTED

Drawn By: JRM

Project Number: 2745-2047 Sheet: A-4 of: 4

Revisions: 06/01/20 PERMIT SET

3) 1/2" DIA. GALV. BOLTS, NUTS AND WASHERS HAND DUG, AUGERED OR CONSTRUCTION TUBE FORMED POST HOLE 2) 1/2" DIA. GALV. BOLTS, NUTS AND WASHERS

RAILING POST INSTALLATION AND SUPPORT

PLAN VIEW